AIR CARGO BUILDING C

COA CONTRACT No. FC-6006007929-A WBS NUMBER -- D.07.55.009 100% CONSTRUCTION DOCUMENTS ISSUED FOR BID SUBMITTAL NOVEMBER 25, 2014









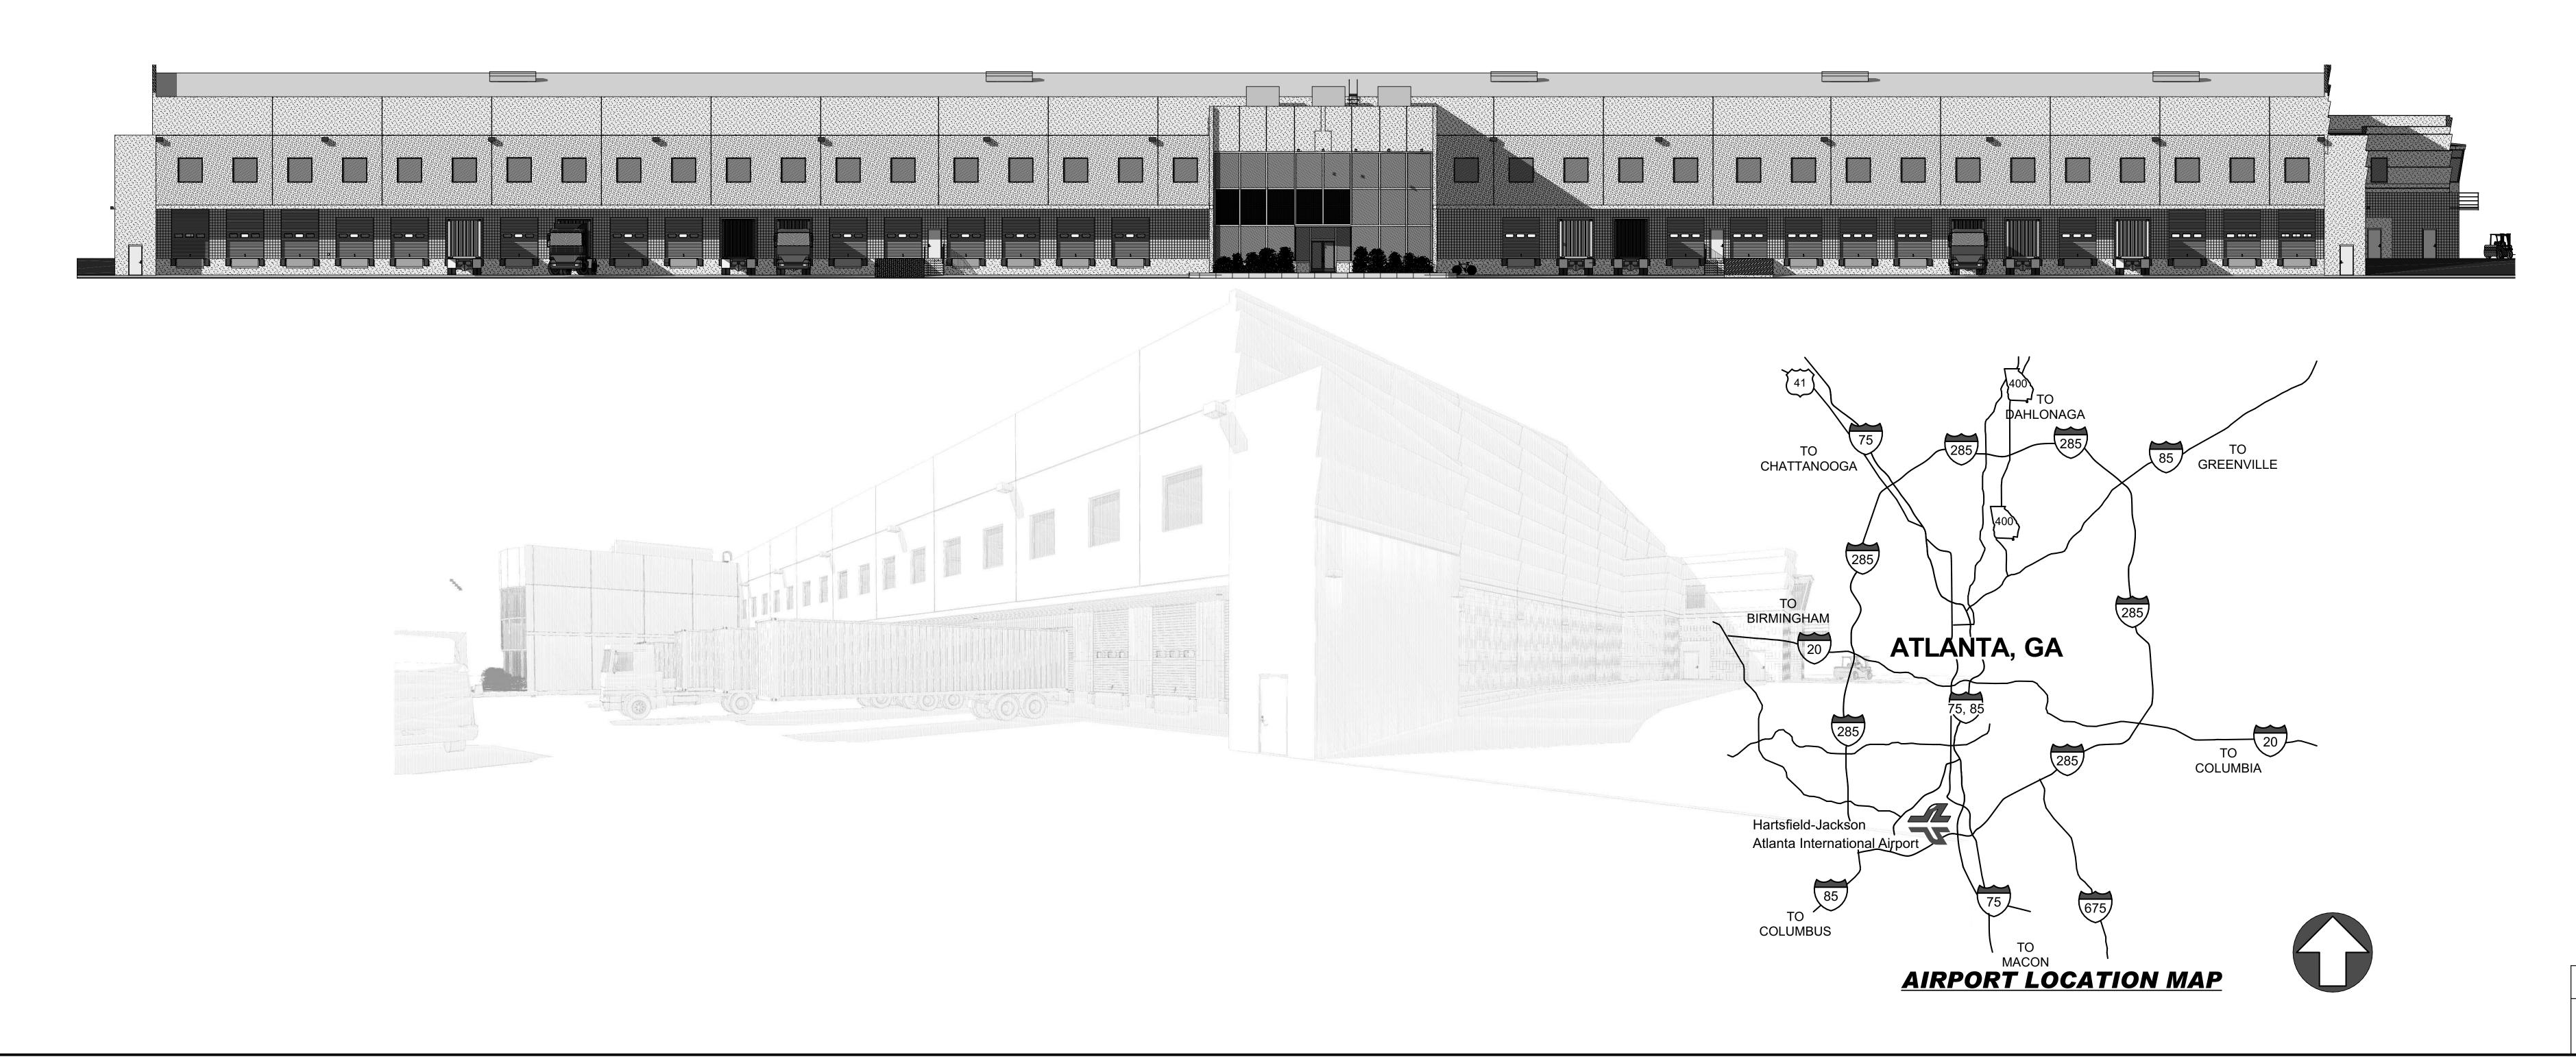
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COVER SHEET

SHEET NO:

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NO. DATE BY REVISION

INDEX OF DRAWINGS

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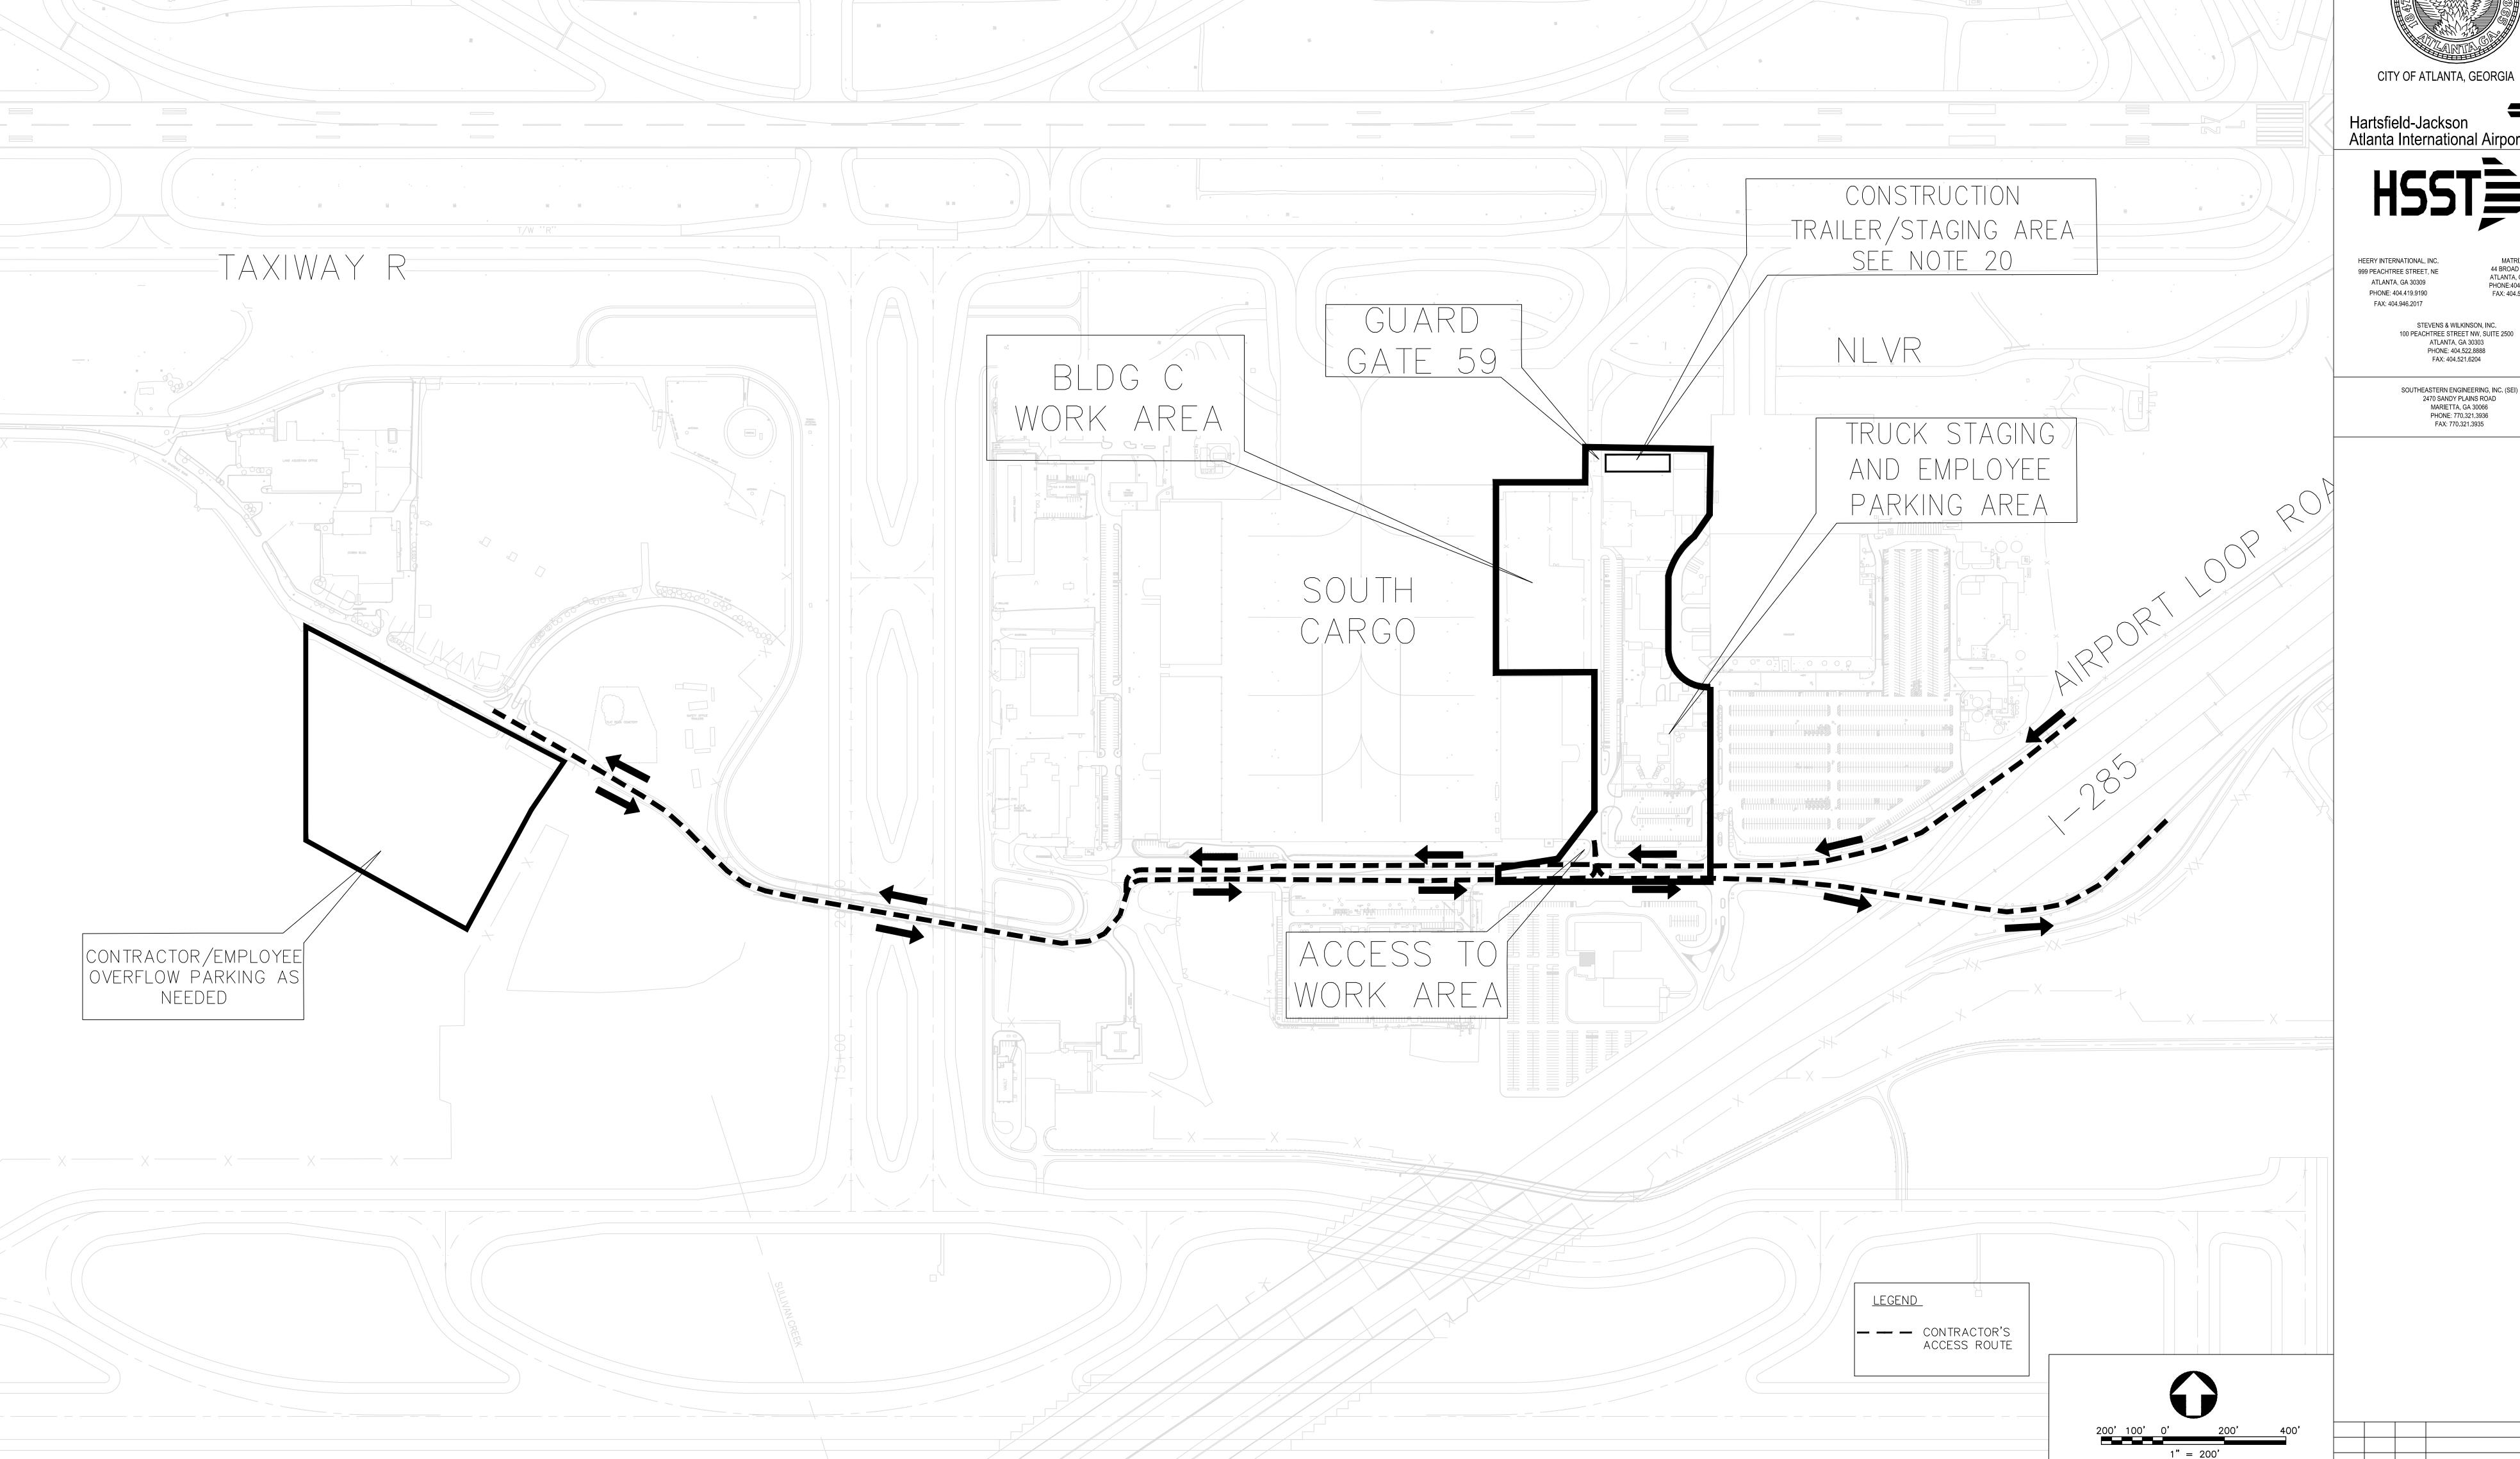
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WBS NUMBER:	DRAWN BY:	
D.07.55.009	SK	
FC NUMBER:	DESIGNED BY:	
FC-6006007929-A	JWS	
A/E PROJECT NUMBER.	CHECKED BY:	
HII-0730621	TR	
	APPROVED BY:	
	WLP	
	DATE:	
	11/25/2014	
	SCALE:	
	N/A	
	SHEET NO:	

INDEX LEGEND

INDICATES SHEET INCLUDED IN THIS ISSUE -**REVISION NUMBER** LATEST ISSUE -



GENERAL NOTES

- 1. ALL WORK SHALL COMPLY WITH APPLICABLE STATE, FEDERAL AND LOCAL CODES.
- 2. ALL MATERIALS AND CONSTRUCTION METHODS TO BE IN ACCORDANCE WITH THE CITY OF ATLANTA HJAIA STANDARDS, AS APPLICABLE.

3. DEVIATION FROM THESE PLANS AND SPECIFICATIONS WITHOUT THE PRIOR

WRITTEN CONSENT OF THE ENGINEER MAY CAUSE THE WORK TO BE

- UNACCEPTABLE. 4. CONTRACTOR IS RESPONSIBLE FOR NOTIFICATIONS AND LIAISON WITH UTILITY COMPANIES IN THE PROCESS OF LOCATING, RELOCATION AND TIE-IN TO PUBLIC UTILITIES.
- 5. THERE MAY BE ADDITIONAL UTILITIES OTHER THAN THOSE SHOWN ON THESE PLANS. THE ENGINEER ASSUMES NO RESPONSIBILITY FOR LOCATIONS SHOWN AND IT SHALL BE THE RESPONSIBILITY OF THE CONTRACTOR TO VERIFY THE LOCATIONS AND NECESSARY INVERTS OF ALL UTILITIES WITHIN THE LIMITS OF CONSTRUCTION. PRIOR TO ANY CONSTRUCTION, THE CONTRACTOR SHALL NOTIFY THE APPROPRIATE DEPARTMENT OF THE UTILITY COMPANIES. THE CONTRACTOR IS RESPONSIBLE FOR THE NOTIFICATIONS AND LIAISON WITH UTILITY COMPANIES IN THE PROCESS OF LOCATING, RELOCATING AND TIE-IN TO THE PUBLIC UTILITIES. IF NECESSARY, THE CONTRACTOR SHALL POTHOLE EXISTING UTILITIES TO VERIFY LOCATION AND ELEVATION.
- 6. IF CONTRACTOR DAMAGES ANY EXISTING UTILITIES DURING CONSTRUCTION, HE SHALL, AT HIS OWN EXPENSE, REPLACE OR REPAIR THE UTILITIES TO ORIGINAL CONDITION AND QUALITY, AS APPROVED BY THE ENGINEER AND REPRESENTATIVE OF THE
- APPROPRIATE UTILITY COMPANY. 7. IN THE CASE OF UNFORESEEN CONSTRUCTION COMPLICATIONS OR DISCREPANCIES, THE CONTRACTOR IS TO NOTIFY THE OWNER'S REPRESENTATIVE PRIOR TO CONTINUING WITH THE WORK.
- 8. ALL COORDINATES ARE BASED ON AIRPORT COORDINATE SYSTEM.

11. ALL EXCESS MATERIAL INCLUDING CLEARING, GRUBBING, DEBRIS,

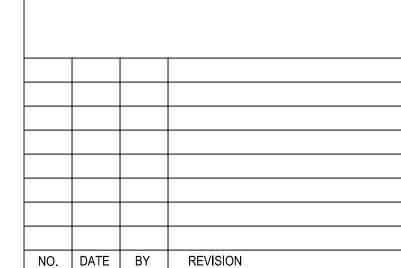
- 9. ALL ELEVATIONS ARE FROM MEAN SEA LEVEL.
- 10. ELEVATIONS INDICATED ARE TOP OF FINISH PAVEMENT.

- SOIL, AND ANY OTHER MATERIAL SHALL BECOME THE PROPERTY OF THE CONTRACTOR AND REMOVED FROM THE SITE.
- 12. GATE 59 WILL BE ACTIVE AND OPERATIONAL DURING A PORTION OF THE CONSTRUCTION OF THIS PROJECT. THE NEW ESCORT GATE 70 WILL BE UNDER CONSTRUCTION AT APPROXIMATELY THE SAME TIME AT A LOCATION WEST OF TAXIWAY SC/SJ. GATE NO. 59 TO BE UTILIZED FOR ESCORTING CHECK IN UNTIL SUCH TIME THAT GATE 70 IS OPEN. ANY ACCESS TO AND EXIT FROM THE AOA SHOULD BE MADE THROUGH SECURITY GUARD POST NO. 59 UNTIL GATE 70 IS OPERATIONAL.
- 13. THE CONTRACTOR IS TO SUBMIT A PROJECT SECURITY PLAN TO THE DOA AND AIRPORT SECURITY FOR APPROVAL PRIOR TO CONSTRUCTION AND/OR IMPLEMENTING ANY SECURITY MODIFICATIONS. THE PLAN MUST ADDRESS, AT A MINIMUM, THE CONTRACTOR'S UNDERSTANDING OF: SECURING THE WORKSITE, KNOWLEDGE OF HAUL ROUTES, IF APPLICABLE, AND THE PROPER USE OF ATL SIDA BADGES. ALSO, THE TEMPORARY SIDA FENCE MUST BE APPROVED BY DOA SECURITY BEFORE CONSTRUCTION COMMENCES.
- 14. ALL PERSONNEL DRIVING ON THE AOA ARE REQUIRED TO TAKE THE DOA DRIVER CLASS.
- 15. THE ROADWAY USED BY THE CONTRACTOR FOR ACCESS OR HAULING TO THE SITE SHALL BE KEPT CLEAN AND ACCESSIBLE TO ALL OTHER SOUTH LOOP ROAD/SOUTH AIR CARGO TRAFFIC FOR THE ENTIRE DURATION OF THE PROJECT. HAUL TRUCKS MUST BE COVERED AND ANY SPILLAGE OR DEBRIS BUILDUP PROMPTLY REMOVED FROM ALL HAUL ROUTES ON AIRPORT AND PUBLIC ROADS. NO SEPARATE PAYMENT SHALL BE MADE FOR KEEPING THE ROADS CLEAR AND ACCESSIBLE.
- 16. THE CONTRACTOR SHALL CONTROL DUST AND DEBRIS FROM HIS OPERATION TO A LEVEL ACCEPTABLE TO THE CITY AT ALL TIMES. THE CONTRACTOR SHALL HAVE ON THE PROJECT SITE VACUUM SWEEPERS, WATERING TRUCKS AND OTHER EQUIPMENT NECESSARY TO CONTROL DUST AT ALL TIMES. ALL METHODS FOR CONTROLLING DUST SHALL BE SUBJECT TO THE CITY'S APPROVAL. DUST CONTROL SHALL BE STRICTLY MONITORED DUE TO IT'S IMPACT ON AIRCRAFT SAFETY. FAILURE TO PROPERLY CONTROL DUST OR TO RESPOND TO ANY REQUEST TO DO SO WILL RESULT IN CONSTRUCTION ACTIVITIES BEING STOPPED.

- 17. ALL EXCESS MATERIAL PRODUCED BY THE CONTRACTOR'S OPERATIONS SHALL BE DISPOSED OF OFF AIRPORT PROPERTY AT NO COST TO THE
- 18. THE CONTRACTOR SHALL COOPERATE WITH THE FAA AND THE CITY WHEN ALIGNING HIS CONSTRUCTION FLOODLIGHTS SO AS NOT TO INTERFERE WITH AIRCRAFT PILOTS OR AIR TRAFFIC CONTROLLERS VISION.
- 19. FAA REGULATION FOR USE OF CRANES AND OTHER ELEVATED EQUIPMENT WILL BE STRICTLY ENFORCED. THE CONTRACTOR SHALL BE RESPONSIBLE FOR SUBMITTING ALL NECESSARY FORMS (7460-1) TO THE CITY AND OBTAINING FAA APPROVAL PRIOR TO CONTRACTOR'S USE OF ANY ELEVATED EQUIPMENT. AN FAA NOTICE OF PROPOSED CONSTRUCTION OR ALTERATION (FORM 7460-1) MUST BE COMPLETED AND SUBMITTED TO THE FAA 45 DAYS PRIOR TO CONSTRUCTION.
- 20. THE CONTRACTOR WITH THE APPROVAL OF THE CITY SHALL ESTABLISH THE EXACT LIMITS OF THE STAGING AREA FOR MATERIAL STOCKPILING. BATCH PLANTS AND OFFICE TRAILERS IN THE AREAS SHOWN ON THE CONSTRUCTION CONTROL PLAN. THE STAGING AREAS ARE CONSIDERED PUBLIC ACCESS AREAS AND SHALL BE ENCLOSED WITH TEMPORARY SECURITY FENCING ACCEPTABLE TO THE CITY. ALL REQUIRED UTILITIES FOR THE CONTRACTOR'S BATCH PLANTS AND STAGING AREA SHALL BE ARRANGED AND PROMPTLY PAID FOR BY THE CONTRACTOR DIRECTLY WITH THE APPROPRIATE UTILITY AGENCY. UTILITY ARRANGEMENTS SHALL BE SUBJECT TO THE APPROVAL OF THE CITY. CONTRACTOR SHALL BE RESPONSIBLE FOR ALL DRAINAGE AND EROSION CONTROL REQUIRED IN STAGING AND STOCKPILE AREAS. NO SEPARATE PAYMENT SHALL BE MADE FOR ANY ITEM REQUIRED FOR THE CONTRACTOR TO ENCLOSE, SET UP, AND MAINTAIN HIS OPERATIONAL AREAS. THE CONTRACTOR SHALL RESTORE THE SITE TO ITS ORIGINAL CONDITION, TO THE SATISFACTION OF THE CITY, UPON COMPLETION OF THE CONTRACT WORK. GRASSING IS PART OF THE SITE'S RESTORATION. NO OBJECT IN THE CONTRACTOR'S STAGING AREA OR BATCH PLANT AREA WITHIN 1000' OF THE VORTAC SHALL HAVE A HEIGHT GREATER THAN THE ELEVATION OF THE VORTAC DECK, WHICH IS APPROXIMATELY 40'+/- ABOVE THE GROUND AT THE ELEVATION AT THE VORTAC.
- 21. ALL CONSTRUCTION ACTIVITIES SHALL BE COORDINATED WITH AIRPORT PERSONNEL THROUGH THE CM. CONTRACTOR SHALL COOPERATE WITH EXISTING AND FUTURE CONTRACTORS WORKING IN THE AREA AND AT ALL TIMES WILL COORDINATE HIS EFFORTS TO MAINTAIN NECESSARY CONSTRUCTION ACCESS ROUTES AND TO PREVENT CONTRACT DELAYS.

CONTRACTOR SHALL, AT ALL TIMES, BE RESPONSIVE TO THE OVERALL NEEDS OF THE AIRPORT COMMUNITY AND LEND FULL COOPERATION TO AIRPORT AUTHORITIES WHEN NEEDED TO ASSURE CONTINUING AIRPORT OPERATION. THE CONTRACTOR SHALL CONDUCT HIS OPERATIONS SUCH THAT THE OVERALL AIRPORT FUNCTION IS MAINTAINED. THE CONTRACTOR SHALL COMPLY WITH ALL LOCAL, STATE, AND FEDERAL LAWS AND REGULATIONS THAT ARE PERTINENT TO THIS WORK. THE CONTRACTOR SHALL HAVE THE RESPONSIBILITY TO OBTAIN AND PAY ALL COSTS ASSOCIATED WITH THE PERMITS AND LICENSES REQUIRED TO ACCOMPLISH

THIS WORK. 22. WORK AROUND EXISTING UNDERGROUND UTILITIES SHALL BE PERFORMED IN A MANNER THAT WILL AVOID DAMAGES TO THE UTILITIES. PRIOR TO COMMENCING WITH WORK, THE CONTRACTOR SHALL ACCURATELY LOCATE OR GET THE APPROPRIATE UTILITY COMPANY TO LOCATE ABOVE AND BELOW GROUND UTILITIES WHICH MAY BE AFFECTED BY THE WORK. THE CONTRACTOR SHALL PROTECT ALL UTILITIES NOT DESIGNATED FOR REMOVAL, RELOCATION, OR REPLACEMENT IN THE COURSE OF THE CONSTRUCTION. THE CONTRACTOR SHALL PROVIDE 72 HOURS OF ADVANCED NOTICE TO THE UTILITY OWNER, CITY, AND FAA PRIOR TO BEGINNING CONSTRUCTION IN THE VICINITY OF THE EXISTING UTILITY LINE. FOR EXISTING UTILITY LOCATION ASSISTANCE CALL THE UNDERGROUND UTILITIES PROTECTION CENTER (UPC) AT 1-800-282-7411.



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AIR CARGO BUILDING C

CONSTRUCTION CONTROL PLAN AND GENERAL NOTES

WBS NUMBER:	DRAWN BY:
D.07.55.009	SEI/JCS
FC NUMBER:	DESIGNED BY:
FC-6006007929-A	SEI/JCS
A/E PROJECT NUMBER.	CHECKED BY:
HII-0730621	SEI/CWE
	APPROVED BY:

11/25/2014 1" = 600'

SHEET NO:

SEAL

SUMMARY OF QUANTITIES

ITEM	DESCRIPTION Mobilization	UNIT	ESTIMATED QUANTITY
	Mobilization Project Contingency	LS ALLOW.	LUMP SUM As Required
	Traffic Control Jtility Coordination and Scheduling	LS LS	LUMP SUM
SP-5-2 L	Jtility Relocation	ALLOW.	As Required
	Atlanta Gas Light Work Watering for Dust Control	ALLOW.	As Required 220.0
	As-Builts Building	LS LS	LUMP SUM
	Removal of PCC Pavement, Including Base Course, 16" Thickness Removal of PCC Pavement, Including Base Course, 9" Nominal Thickness	SY SY	270 1360
	Removal of Asphalt Pavement, Including Base Course, 4" Nominal Thickness Removal of Curb and Gutter	SY LF	9500 4640
P-150-5 F	Removal of Sidewalk Pavement	SY	510
	Removal of Sanitary and Storm Sewer Pipes, 15" Diameter or Greater Drainage and Sanitary Sewer Structure Removal	LF EA	1990 14
	Fence Removal Milling of Bituminous Pavement, 1.5 inch Depth	LF SY	1960 1450
7-130-9	willing of bituminous Favernerit, 1.3 mon beptil	31	1430
	n Place Embankment Backfill	CY CY	5000 10000
	Preparation of Subgrade	SY	54260
	French Rock Excavation Rock Excavation	CY CY	10
P-156-1 S	Sediment/Erosion Control	LS	LUMP SUM
	Silt Fence nlet Sediment Trap	LF EA	3820 30
P-156-4 II	nlet Sediment Filter with Bags	EA	24
2-209-1	Crushed Aggregate Base Course	СУ	6480
	Recyc Asph Conc 12.5 MM Superpave, Gp. 1 or 2, Incl Bit Matl & H	TN	660
P-402-2 F	Recyc Asph Conc 25 MM Superpave, Gp. 1 or 2, Incl Bit Matl & H Lime	TN	930
	Non-reinforced Portland Cement Concrete Airfield Pavement, 16" Thick Reinforced Portland Cement Concrete Airfield Pavement, 16" Thick	SY SY	130 710
P-501-3 N	Non-reinforced Portland Cement Concrete Pavement, 10" Thick	SY	14490
	Reinforced Portland Cement Concrete Pavement, 10" Thick Non-reinforced Portland Cement Concrete Pavement, Variable Thickness 10" to 12.5" Thick	SY SY	3500 400
P-501-6 F	Reinforced Portland Cement Concrete Pavement, Variable Thickness 10" to 12.5" Thick Low Slump, Low Strength concrete	SY CY	520 290
	Non-reinforced Portland Cement Concrete Pavement, High Early Strength, 10" Thick Reinforced Portland Cement Concrete Pavement, High Early Strength, 10" Thick	SY SY	500 50
P-602-1 E	Bituminous Prime Coat	GAL	4140
	Bituminous Tack Coat	GAL	1240
			1240
	Cold Applied Sealant, Contraction, Construction and Longitudinal Joints Cold Applied Sealant, Expansion Joints	LF LF	17500 640
P-605-3	Cold Applied Sealant, Asphalt-Concrete Joint Interface	LF	100
P-615-1 (Concrete Curb and Gutter	LF	12630
	Concrete Ditch Paving Concrete Sidewalk	CY SY	20 480
	Concrete Island Paving	SY	360
P-621-1 F	Pavement Striping and Marking Removal	SF	1970
P-621-2 F	Pavement Striping and Marking	SF	9100
	Storm Sewer, RCP, 18" Diameter Class V	LF	250
	Storm Sewer, RCP, 24" Diameter Class V Storm Sewer, DIP, 6" Diameter	LF LF	1060 230
	Pipe Bedding, Type "C"	LF	1480
	Trench and Excavation Protection Roof Drain Leader Cleanout	LS EA	LUMP SUM 2
D-705-1 6	5" Perforated Underdrain Pipe	LF	1110
D-705-2	Coarse Aggregate Underdrain Backfill, #89 Stone	CY	100
D-705-3 L	Jnderdrain Cleanout	EA	6
	S" DIP Sanitary Sewer Pipe Sanitary Sewer Lateral Cleanout	LF EA	80
D-750-3 F	Raise Sanitary Sewer Manhole to grade	EA	2
D-750-4 C	CCTV Pipe Inspection	LF	600
	GDOT 1019AP - Type E Hood and Grate GDOT Modified 1019AP - Type E Double Hood and Grate (9031L Sheet 2)	EA EA	1 4
D-751-3	GDOT 1019AP - Type C Drop Inlet	EA	6
	GDOT 1034DP - Double Wing Catch Basin Standard Drainage Manhole - GDOT 1040	EA EA	1 1
)-751-6 C	GDOT 1001B - Headwall Replace ATL Type A w/ GDOT Type C Drop Inlet to grade	EA	2
D-751-8 F	Raise Storm Manhole to grade	EA EA	6 4
D-751-9 N	Miscellaneous Concrete	CY	50
	Femporary SIDA Fence and Removal	LF	770
	Permanent SIDA Fence 8-ft Wide Permanent Swing Gate	LF EA	30
F-165-1 S	Signs, Type 1 Material, Reflective Sheeting Type 3	SF	50
F-165-2 S	Signs, Type 1 Material, Reflective Sheeting Type 9	SF	50
F-165-3 C	Galvanized Steel Posts, Type 7	LF	380
	Seeding Reseeding (Permanent Seed)	SY SY	21720 19150
	Watering, for Seeded Areas	HR	220
T-904-1 S	Sodding	SY	2580
T-908-1	Asphalt Spray Mulching	SY	58000
116-1 3	3" Water Line Directional Drill	LF	40
	3-inch Class 51 Ductile Iron Pipe, Restrained Joint 6-inch Class 51 Ductile Iron Pipe, Restrained Joint	LF LF	170 120
J-150-3 8	3-inch Class 51 Ductile Iron Pipe, Restrained Joint	LF	240
	2-inch Class 51 Ductile Iron Pipe, Restrained Joint Fire Hydrant Assembly	LF EA	100 5
J-150-6 8	B-inch Post Indicator Valve	EA	1
U-150-7 3	3" Water Meter Including meter box	EA	1



Hartsfield-Jackson



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> STEVENS & WILKINSON, INC. 100 PEACHTREE STREET NW, SUITE 2500 ATLANTA, GA 30303 PHONE: 404.522.8888 FAX: 404.521.6204

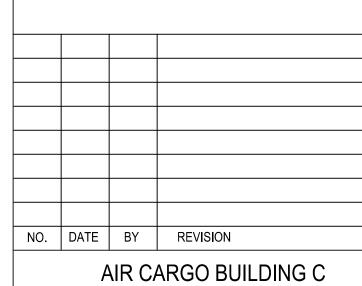
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AIR CARGO BUILDING

SUMMARY OF QUANTITIES

WBS NUMBER:	DRAWN BY:
D.07.55.009	SEI/JCS
FC NUMBER:	DESIGNED BY:
FC-6006007929-A	SEI/JCS
A/E PROJECT NUMBER.	CHECKED BY:
HII-0730621	SEI/CWE
l .	I

DATE: 11/25/2014

ALE: EET NO:

G 3.1.1

Cargo Building C - 2013 HII - 07306-21

Exit Access: [Per Ga IBC Amendments: NFPA as Basis; IBC to be used as a supplement for areas not

hour rating in accordance with 8.3.

through 43. • 38.3.6.1, Except. No 3: No separation required for exit access corridors in

Doors to exit access corridors 20 min/ 1 hr [where corridor protection is required]

2012 National Fire Protection Association (NFPA) 101 Life Safety 2012 International Plumbing Code with Georgia Amendments 2012 International Mechanical Code with

Georgia Amendments 2011 National Electrical Code with no Georgia Amendments 2009 International Energy Conservation Code with 2012 Georgia

supplements and Amendments 2010 ADA Standards for Accessible Design.

II. Occupancy Classification
[NFPA 101 shall establish minimum requirements for occupancy classifications, overruling

Mixed, Separated: Business and Storage, Ordinary Hazard [6.1.14; Chapter 38 and Chapter 42]

III. Occupant Loads: [NFPA Table 7.3.1.2, IBC Table 1004.1.1–more stringent code applies]: Function of Space Square Foot Area/Occupant No. of Occ

Function of Space	Square Feet	Area/Occupant	No. of Occ.	
Office	21,035 GSF	100 GSF	210	
Ramp Operations 1st	1,149 GSF	100 GSF	11	
Ramp Operations	1,260 GSF	100 GSF	13	
2nd				
Entry 1st	3,362 GSF	100 GSF	34	
Entry 2nd	2,695 GSF	100 GSF	27	
Warehouse	100,930 GSF	500 GSF	202	
Total Floor Area:	130,431 GSF	Total Occu	pancy: 497	

Refer to IBC Section 602 Construction Classification and Table 601 Fire Resistance Ratings for Building Elements. IBC shall establish minimum requirements for

Type: IBC: Type II-B, unprotected, sprinklered

Max. Allowable Ht: Storage S-2 55'-0" [IBC Table 503] Business B 55'-0" (No Height modifications needed)

• 3 stories for type Storage S-2: [IBC Table 503]

 3 stories for Business B [No Story Increase needed]

100,930 GSF First Floor, Storage [S-2]: First Floor, Business [B]: 4,511 GSF

24,990 GSF o S-2 = 26,000 [IBC Table 503]

If = [1468/1498 -0.25] 54/30

Area Increase: $A = \{26,000+[26,000 *1.3]+[26,000*2]\}$ A = 26,000 + 33,800 + 52,000A = 113.800

Area Increase: $A = \{23,000+[23,000 *1.3]+[23,000*2]\}$ A = 23,000 + 29,900 + 46,000A = 98,900

WAREHOUSE

Building meets current area and height limitations.

[Per Ga IBC Amendments: Table 601 and 602 of IBC; NFPA to be used as a supplement for IBC Table 601 u.n.o.

Exterior Non-Bearing Walls & Partitions: Interior Non-Bearing wall & Partitions: Floor/Ceiling Construction: Roof/Ceiling Construction:

**Table 602: Fire-Resistance Rating requirements for Exterior Walls Based on Fire [For Type IIB construction, Occupancy B and S-2] 0 hr

Occupancy Separation Requirements: [Per Ga. IBC Amendments; IBC Table 508.4 and NFPA 6.1.14.] Separation Reg'd IBC: Storage S-2 and Business

NFPA: Storage [Ordinary Hazard] and Business

1. NFPA 7.1.3 - Corridors used as exit access serving an area with an occupant load > 30 shall be separated from other parts of the building by walls having not less than 1 Exception No. 2: Shall not apply where otherwise provided in Chapters 11

sprinklered Business Occupancies.

Exit Enclosures: [Per Ga IBC Amendments: NFPA as Basis; IBC to be used as a supplement for areas not addressed by NFPA.]

1. All inside stairs serving as an exit shall be enclosed according to 7.1.3.2; all other inside stairs shall be protected in accordance with 8.2.5. Exit Separation –

 3 or less stories [NFPA 7.1.3.2.1, a] • 4 or more stories [NFPA 7.1.3.2.1, b] 2 hours

Exception For Ramp Ops Area: Business, [NFPA 38.2.4.2, Exc. No. 5] allows an unprotected stair to be the single exit in a two-story, single tenant, sprinklered building where the total travel distance to the outside is <100'-0". Exception For Customer Service:

 Where permitted by Chapters 11 – 43, unenclosed vertical openings not concealed within the building construction shall be permitted as follows[NFPA 8.6.9.1]

(1) Opening connects no more than 2 adjacent stories (2) Opening separated from unprotected vertical openings serving other (3) Openings shall be separated from other fire or smoke compartments

(4) Opening shall be separated from corridors (5) Opening shall not serve as a required means of egress

Vertical Openings: 1. Shaft Enclosure – 4 stories or more [NFPA 8.6.5] 2 hours

2. Other Shaft enclosures [NFPA 8.6.5] Vertical Openings that do not extend to the top or bottom shall be enclosed at the lowest or highest level in accordance w/8.6.5. [NFPA 8.6.4.1] Any vertical opening shall be enclosed or protected in accordance with NFPA

3. Elevator Lobbies not required per Ga Amendment 713.14.2, Exception 4. 'Buildings three stories or less with vertical openings protected in accordance with the applicable occupancy chapter'.

Opening Protectives: [NFPA 2012 8.3.4.2.3]

1. 2-hr fire barrier 1½ hr 2. 1-hr vertical shaft & exit enclosure walls 1 hr

3. Other 1-hr walls [unless a lesser fire protection rating is specified in Chapt. 11 – 43.] 4. ½-hr fire barrier

VI. Exiting Requirements [NFPA shall establish minimum requirements for means of egress and all components thereof, including all separate categories below, overruling IBC (Ga. 120-3-3.01 (a))] Minimum Number of Exits:

where the total travel to the outside does not exceed 100 ft.

1. At each story [NFPA 7.4.1.1] 2 exits 2. For Business, [NFPA 38.2.4.2, Exc. No. 5] A single exit shall be permitted for a maximum two-story, single-tenant space

Arrangement of Means of Egress

 In buildings protected by an approved sprinkler system, the minimum separation distance between two exits shall be not less than 1/3 the length of the maximum overall diagonal dimension of the building or area to be served. [NFPA 2012, 7.5.1.3.3] – diagonal distance = 560'-0", separation distance > 187'-0"; actual

protected throughout by an approved, supervised automatic sprinkler system.

separation distance = 188'-0" Exit access from rooms or spaces shall be permitted to be through adjoining or intervening rooms, provided such adjoining rooms are accessory to the area served. Foyers, lobbies and reception rooms constructed as required for corridors shall not be construed as intervening rooms. [NFPA 2012, 7.5.1.6]

Maximum distances [NFPA 2012, Table A.7.6.]: Storage, Ordinary Hazard <u>Limit Type:</u> <u>Allowable:</u> 100 ft sprinklered Common path of travel 100 ft sprinklered Dead end corridor 400 ft sprinklered Travel distance limit

Limit Type: <u>Allowable:</u> 75 ft sprinklered Common path of travel 50 ft sprinklered Dead end corridor 300 ft sprinklered Travel distance limit

Egress Capacity (NFPA 2012 7.3.3) and Minimum Widths (NFPA 2012 7.3.4): [use most restrictive occupancy Required Exit Widths: [NFPA 2012 Table 7.3.3.1]

Stairways: .3" per person Level components & ramps: .2" per person 44" min. [NFPA 38.2.3.2] Min. Means of Egress Width: Door width 32" [NFPA 7.2.1.2.4]

Cargo Building C - 2013

HII - 07306-21 **Means of Egress Features:** Egress Stair: [NFPA Table 7.2.2.2.1.1(a)] Stair width Maximum riser height Minimum riser height Minimum tread depth 6'-8" Minimum headroom Maximum height between landings 12'-0" Landings [NFPA 7.2.2.3.2]

Min. width to match width of stair, min. dimension in direction of exit travel to match width of stair, or 4'-0" for stairs with straight runs 1½" projection, or 30° from vertical

same as width of ramp

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Tread nosing [NFPA 7.2.2.3.3]

Ramp landing width

Ramps: [NFPA 7.2.5.2(a)] Ramp width Maximum Slope 1" in 12" 1" in 48" Maximum cross slope Maximum rise for single run Ramp landing depth [NFPA 7.2.5.3.2] 60" min.

Doors shall swing in the direction of egress travel for occupant load of 50 or

more. [NFPA 7.2.1.4.2] Doors shall swing in the direction of egress travel when used in an exit

enclosure. [NFPA 7.2.1.4.2] During its swing, any door in a means of egress shall leave not less than ½ the required egress width and shall not project more than 7" into the required egress width when fully open. [NFPA 7.2.1.4.3]

 Doors shall not open directly into a stair without a landing. [NFPA 7.2.1.4.3] **Egress Pathway:** Minimum ceiling height in means of egress shall be 7'-6", with projections

down to 6'-8" allowable for up to 1/3 of the ceiling area. [NFPA 7.1.5] Guards shall be provided within 30" of all portions of required egress width of stairs. Ramps and stairs shall have handrails on both sides. [NFPA

The exit discharge shall be arranged and marked to make clear the direction of egress to a public way. Stairs shall be arranged so as to make clear the direction of egress to a public way. [NFPA 7.7.3]

 Stories of buildings are permitted to act as areas of refuge in buildings protected throughout by an approved sprinkler system. [NFPA 7.2.12.1, Except. 1 and NFPA 38.2.2.12]

VII. Fire Extinguishers [NFPA 10 Table 3-2.1] For ordinary hazard occupancy, extinguishers are to be within 75' travel distance from any point in the building. There is an exception to this in storage areas where forklift or cart operators are the primary occupants. Vehicle mounted extinguishers approved by the AHJ will allow the elimination of fire extinguishers in the middle of the warehouse. (See NFPA 1: Fire Code Handbook, 13.6.2 for details).

VIII. Plumbing Fixture Counts (Up to 50% of water closets can be substituted as urinals (IBC 419.2))

• **Storage**: 202 occupants/2 = 101 Male WC/Urinals 1 per 100 occupants 1 per 100 occupants Male Lavatories 1 per 100 occupants Female Lavatories 1 per 100 occupants • **Business:** 295 occupants/2 = 147 Male WC/Urinals 1 per 25 for the first 50 occ. 1 per 50 thereafter Female WC 1 per 25 for the first 50 occ. 1 per 50 thereafter Male Lavatories 1 per 40 for the first 80 occ. 1 per 80 thereafter Female Lavatories 1 per 40 for the first 80 occ. 2

1 per 80 thereafter

 Drinking fountains: Storage: 1 per 1,000 occupants = 1 required Business: 1 per 100 = 3 required

Energy Conservation [IECC Table 802.2] For commercial building type (IECC 101.3.2)

I. Energy Code Analysis: Clayton County – Climate Zone 3A

II. Building Envelope Requirements [Table 502.1.2] R-20, ci [min] a. Roof, Insulation entirely above deck b. Mass Walls above grade R-7.6, ci [min] c. Metal Framed Walls above grade R-13 + R3.8, ci [min] No Requirement d. Walls below grade e. Unheated slab No Requirement f. Floors over outdoor air/uncond space U-1.45 g. Roll-up Doors h. Swinging Doors U-0.70 III. Fenestration [Table 502.3] a. Metal Curtainwall/storefront Framing U-0.60 max

c. SHGC: PF < 0.25 0.25 IV. Miscellaneous

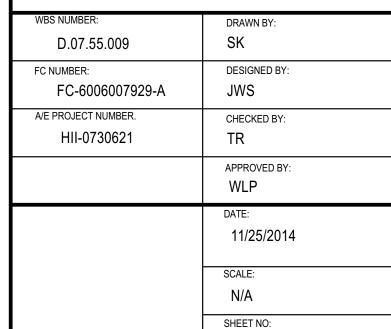
b. Metal Entrance Door Framing

a. 502.4.6 Cargo Doors and loading dock doors shall be equipped with weather seals to restrict infiltration when vehicles are parked in the doorway. b. 502.4.7 Vestibules: Not required for doors that open directly from a space less than 3,000 sq ft in area [exception 4].

U-0.90 max

A SECURITY PLAN MUST BE SUBMITTED TO AIRPORT SECURITY FOR REVIEW BEFORE CONSTRUCTION COMMENCES. THE PLAN MUST ADDRESS, AT A | MINIMUM, THE CONTRACTOR'S UNDERSTANDING OF | SECURING THE WORKSITE, KNOWLEDGE OF HAUL ROUTES, IF APPLICABLE AND PROPER USE OF ATL SIDA BADGES. ALSO, THE TEMPORARY SIDA FENCE MUST BE APPROVED BY DOA SECURITY BEFORE CONSTRUCTION COMMENCES.

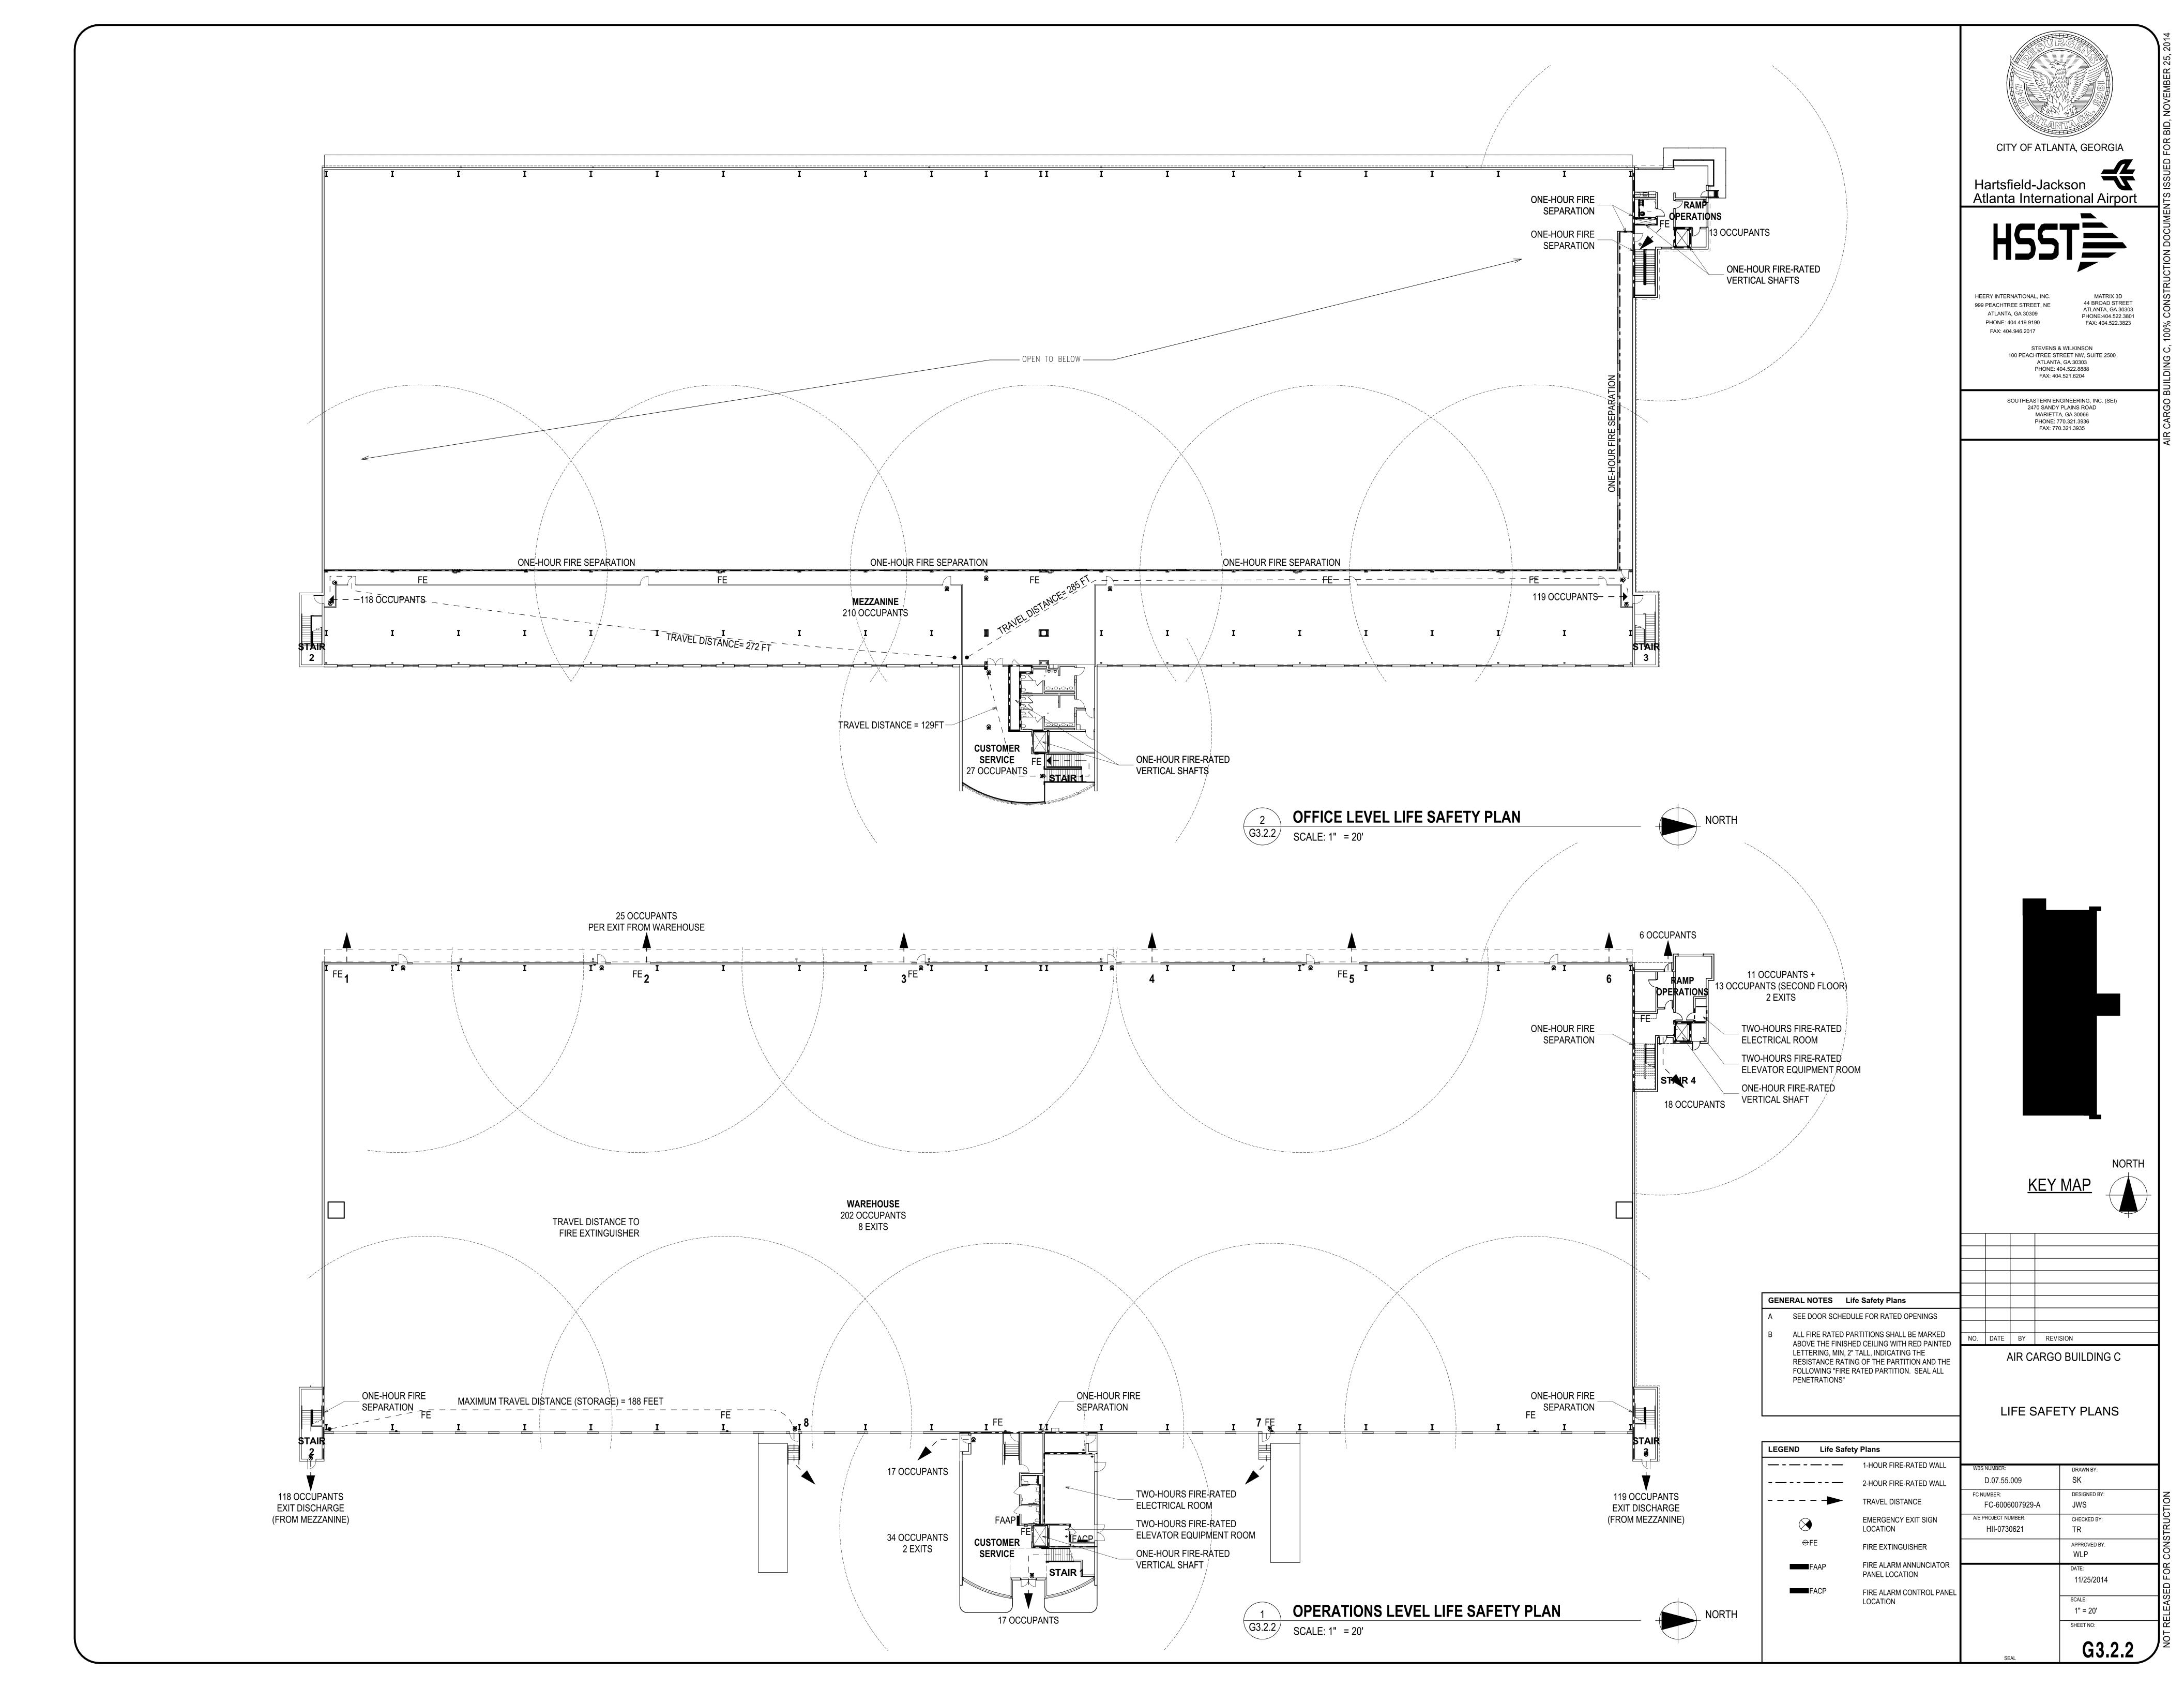


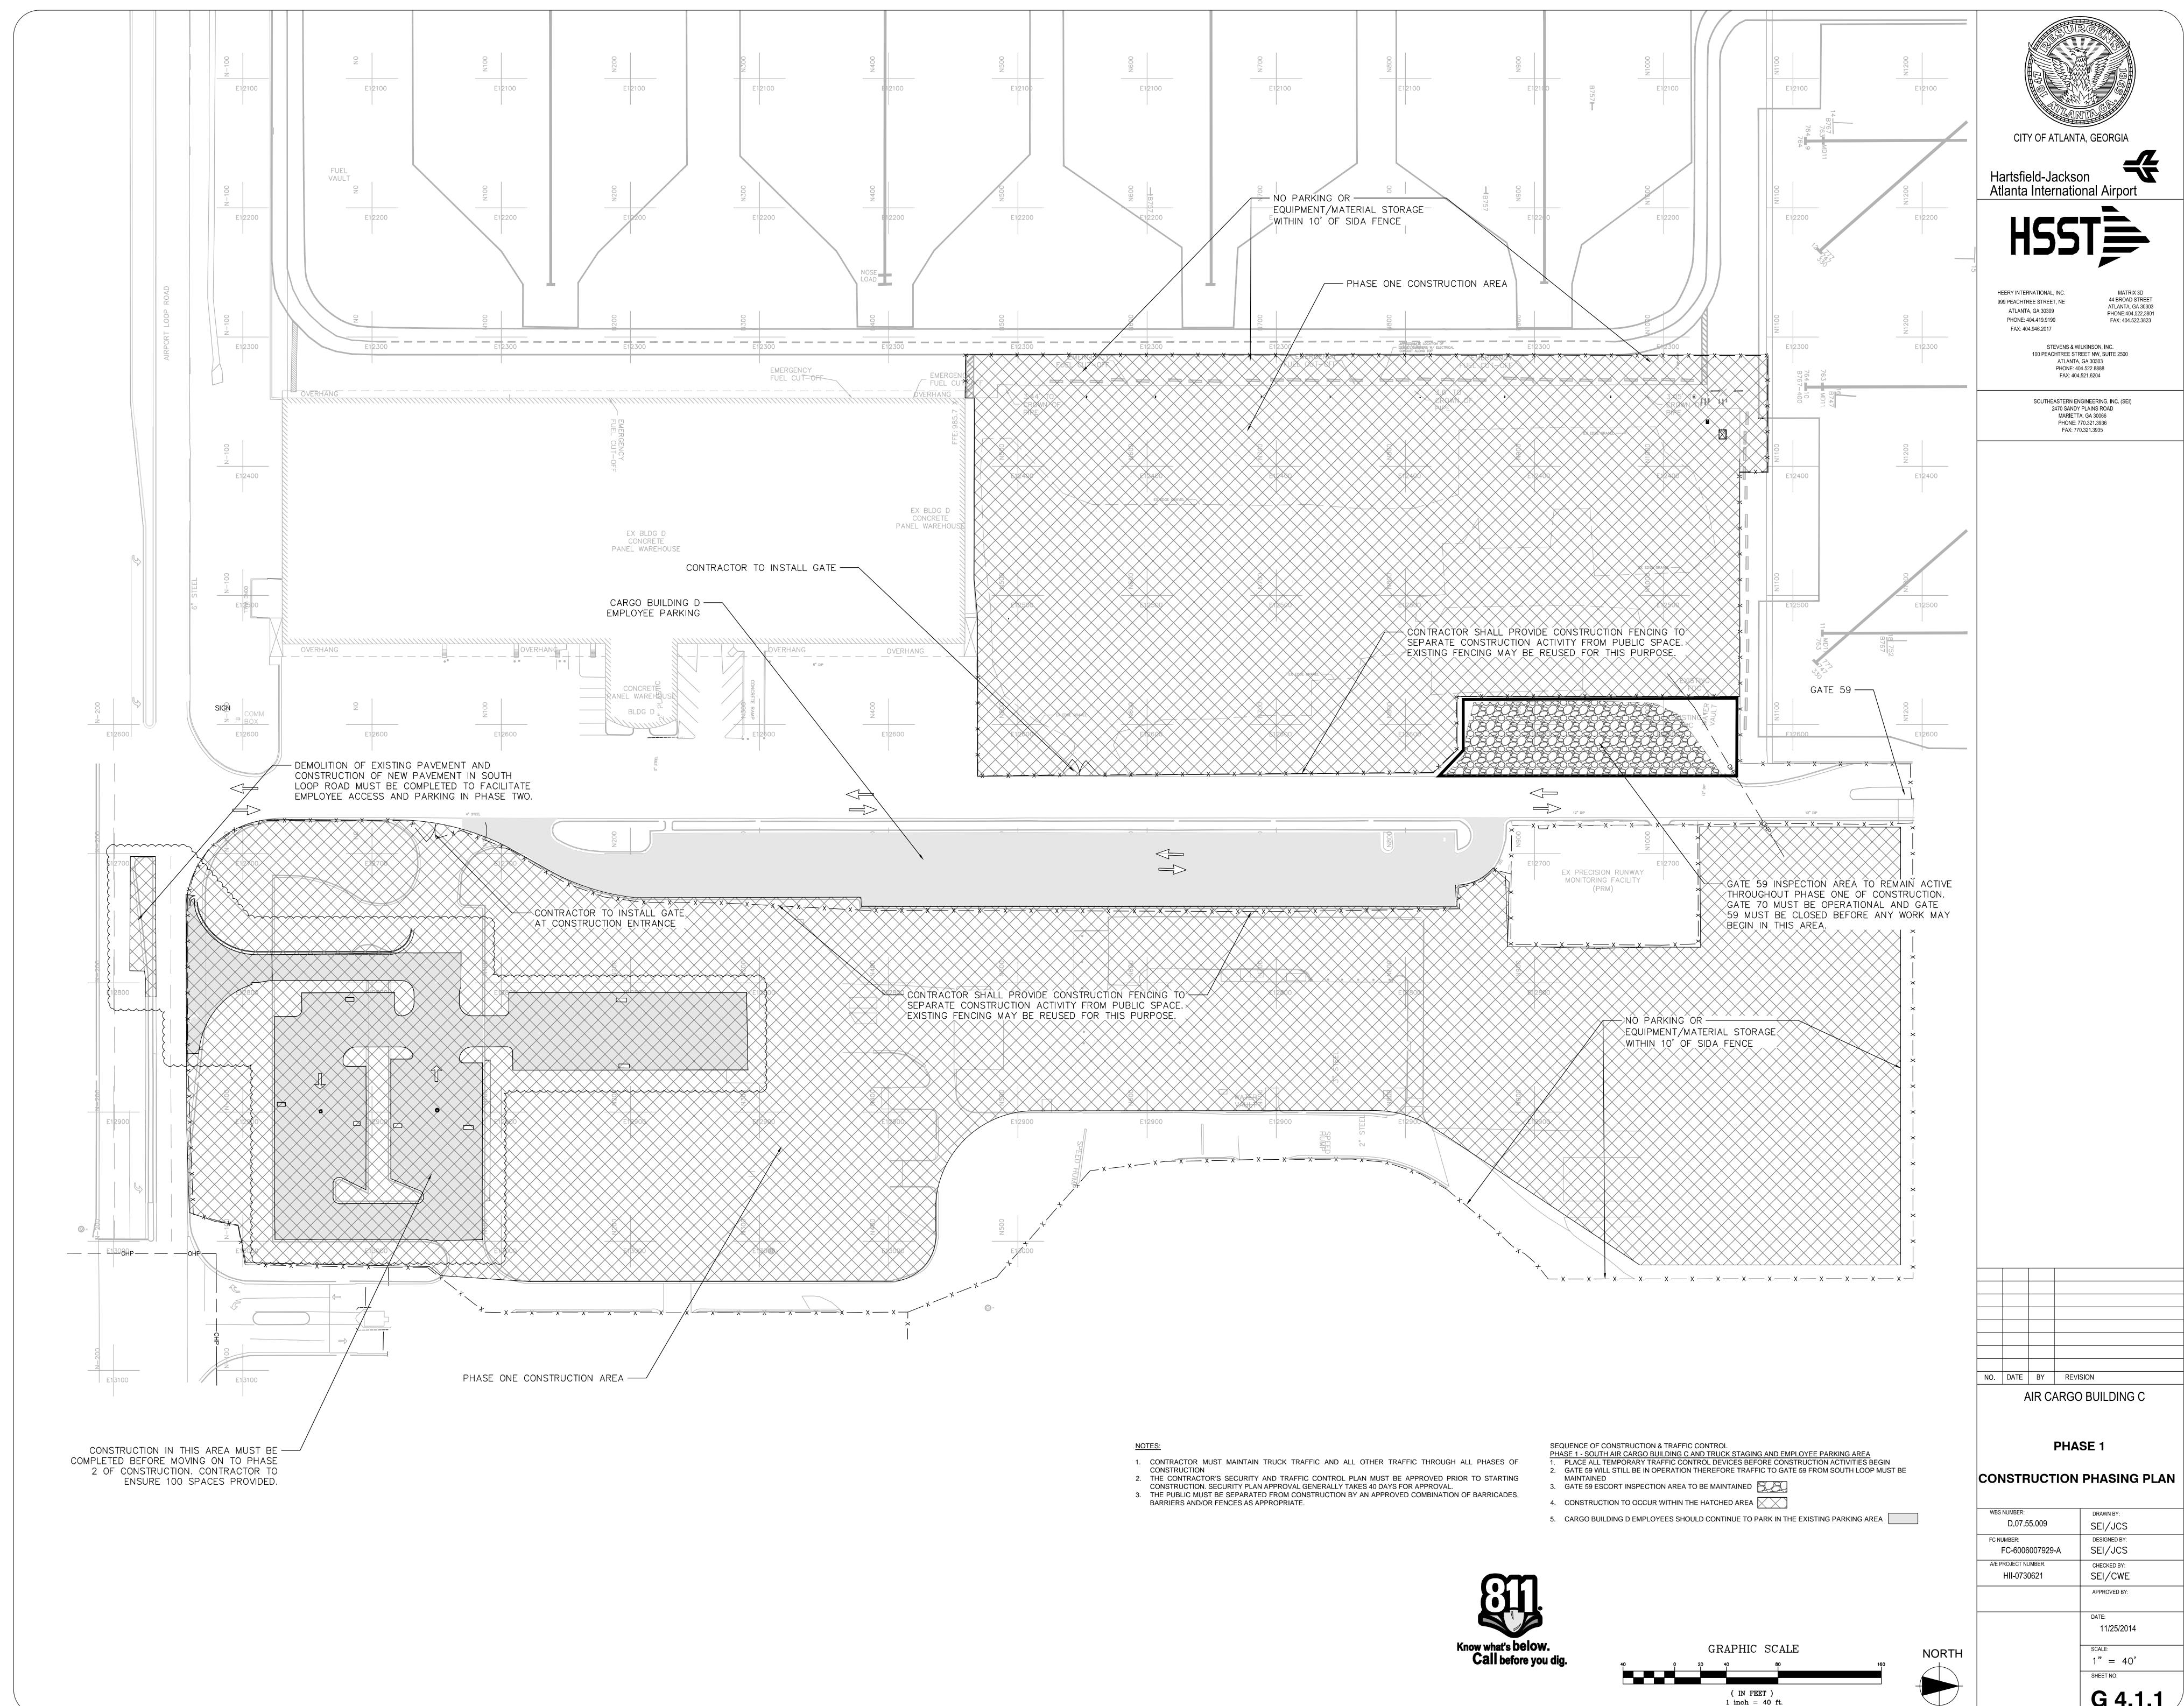


BUILDING SECTION

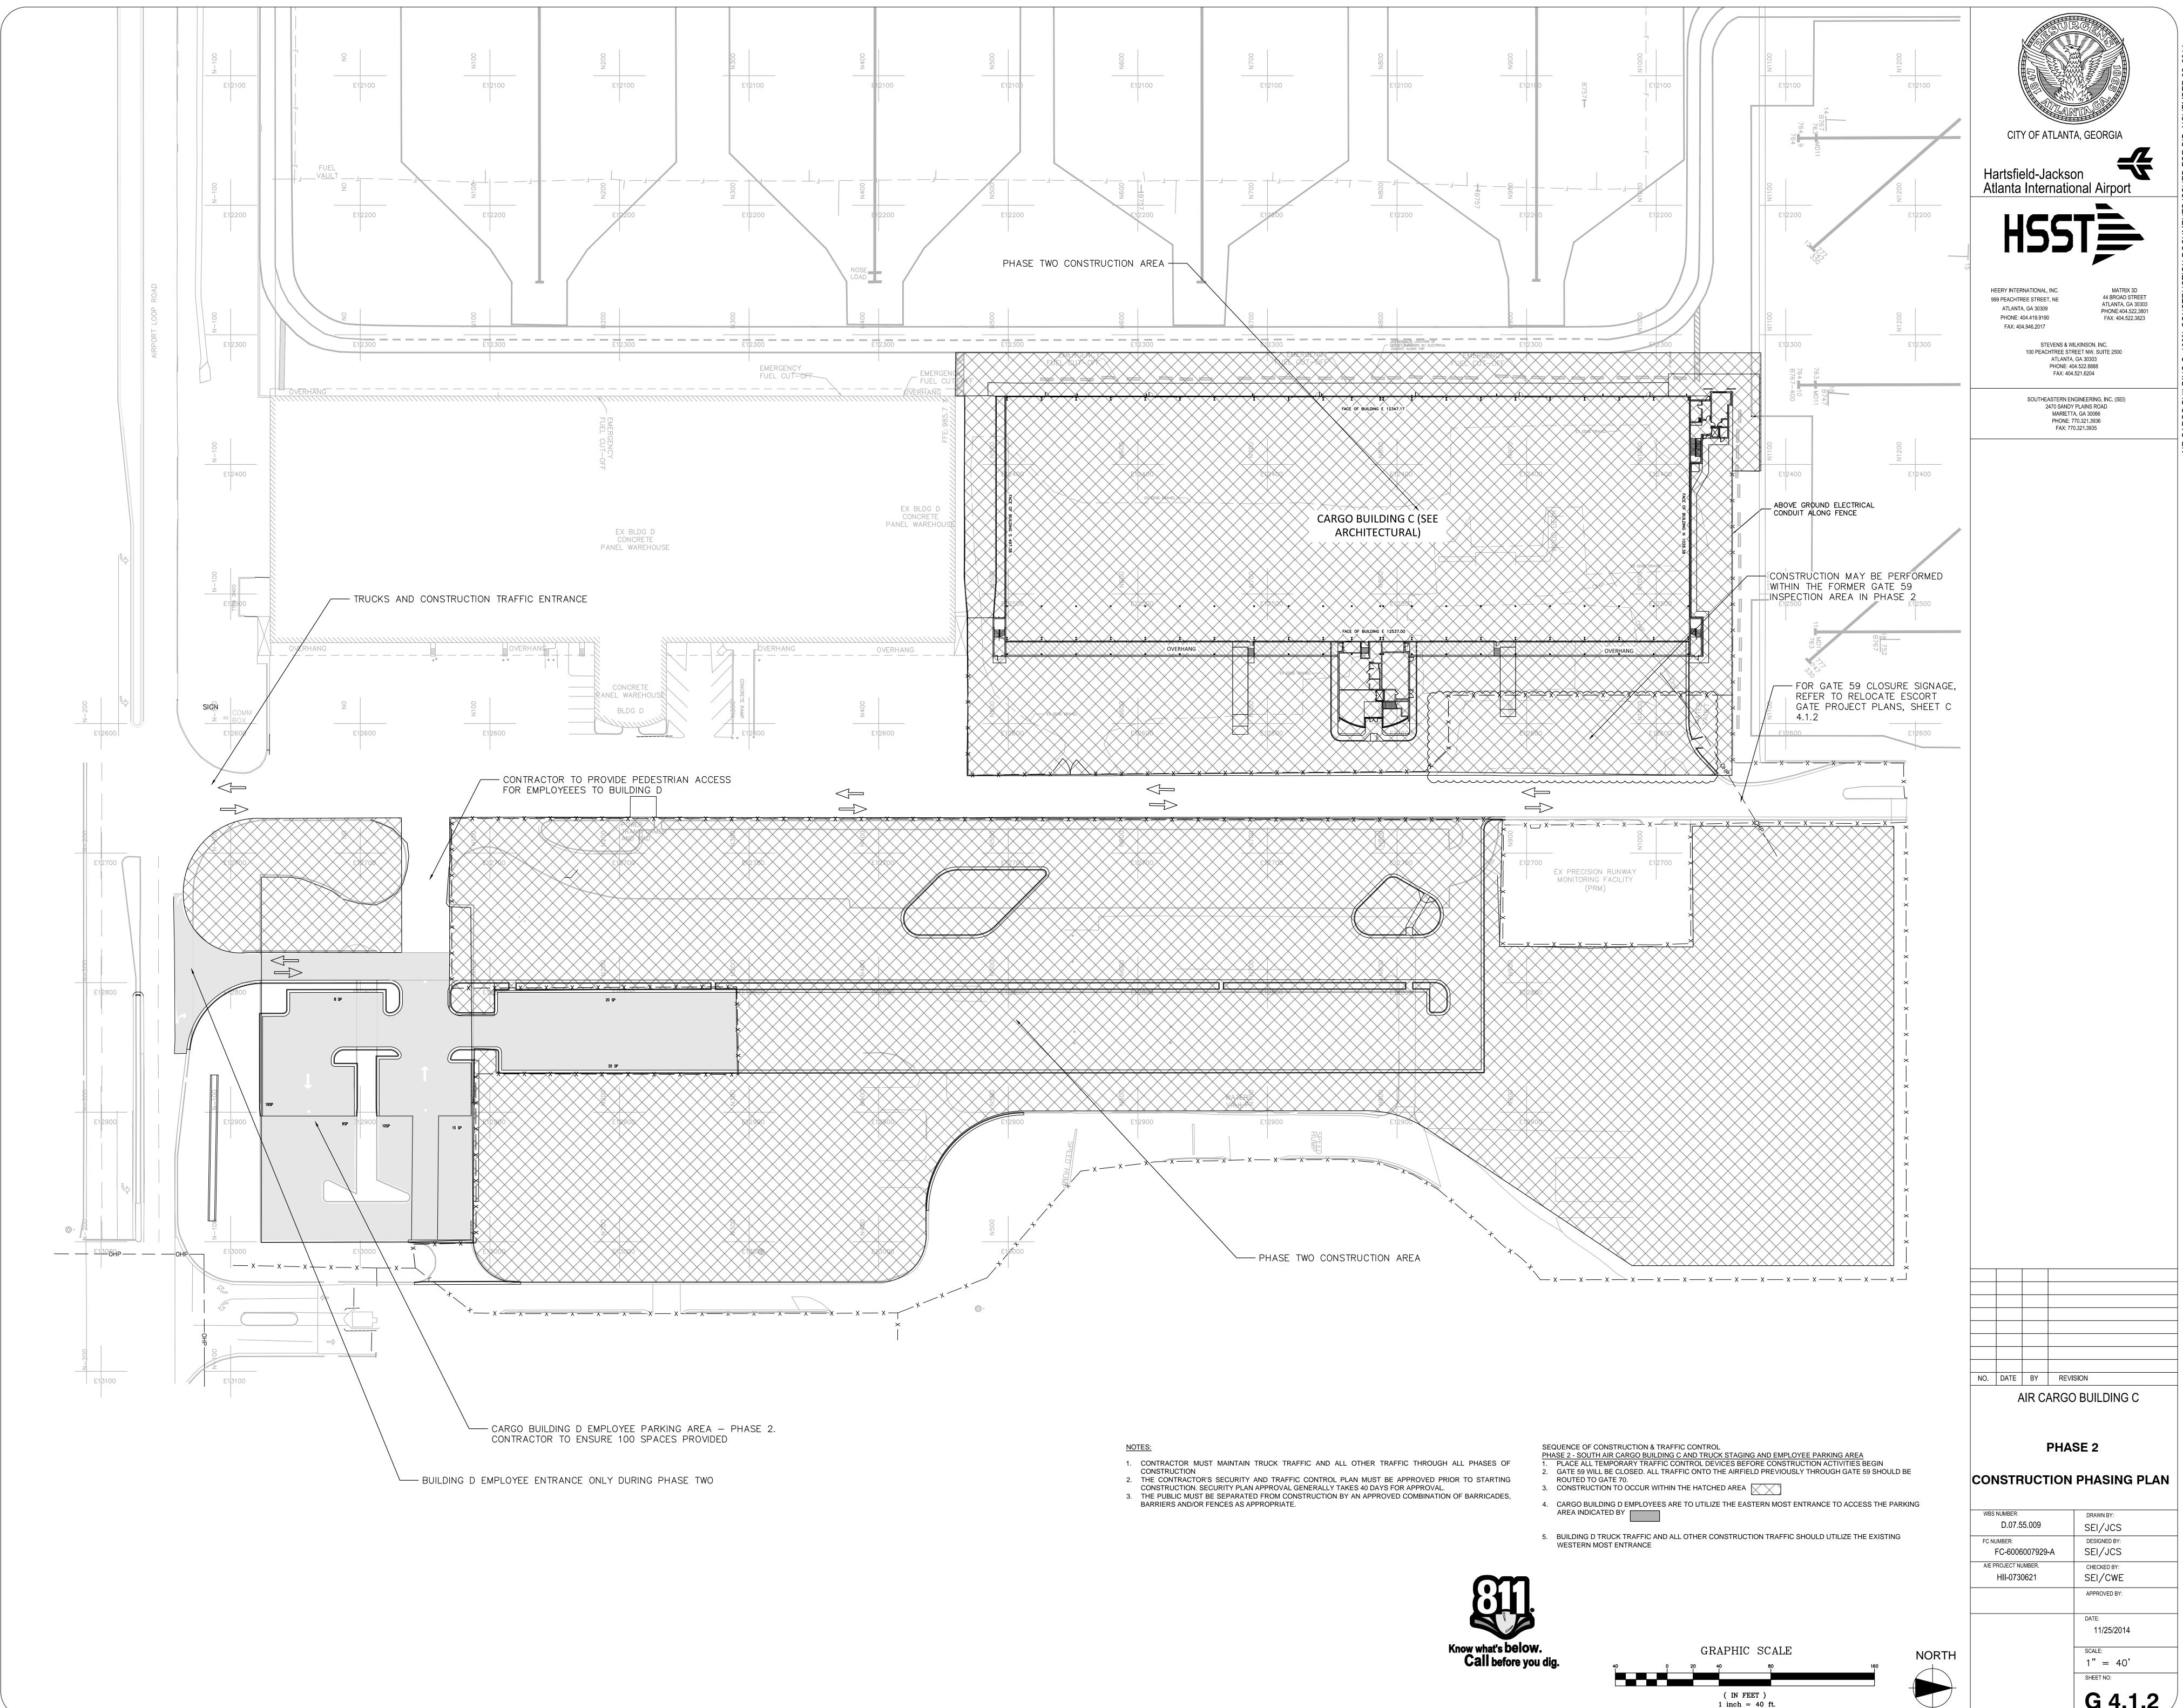
OFFICE

IEZZANINE





WBS NUMBER:	DRAWN BY:	
D.07.55.009	SEI/JCS	
FC NUMBER:	DESIGNED BY:	
FC-6006007929-A	SEI/JCS	
A/E PROJECT NUMBER.	CHECKED BY:	
HII-0730621	SEI/CWE	
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